

# **DRAWING LIST**

DA01 - Cover Sheet	C
DA02 - Site Plan	В
DA03 - Land Acquisition Plan	В
DA04 - Demolition Plan	В
DA05 - Landscape Plan	C
DA06 - Site Staging Plan	В
DA07 - Public Domain: Lang St	C
DA08 - Public Domain: Barton St	C
DA10 - Lower Ground Plan	C
DA11 - Ground Plan	C
DA12 - First Floor Plan	В
DA13 - Roof Plan	В
DA20 - South and East Elevations	C
DA21 - North and West Elevations	B
DA22 - Sections AA + CC	В
DA23 - Detail Sections	В
DA25 - Window Schedule	A
DA26 - Signage Schedule	В
DA30 - Shadows 9am June 22nd	A
DA31 - Shadows 12pm June 22nd	Ak
DA32 - Shadows 3pm June 22nd	A
DA35 - Materials Schedule	В
DA36 - GFA Plan	В

# **DEVELOPMENT APPLICATION**






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PROJECT TITLE: Drawing Title 174-178 LANG STREET, KURRI KURRI Drawing Scale ISSUED FOR Issue Date DEVELOPMENT APPLICATION Revision

SITE PLAN 1:1000@A3 21/08/2023 DA02





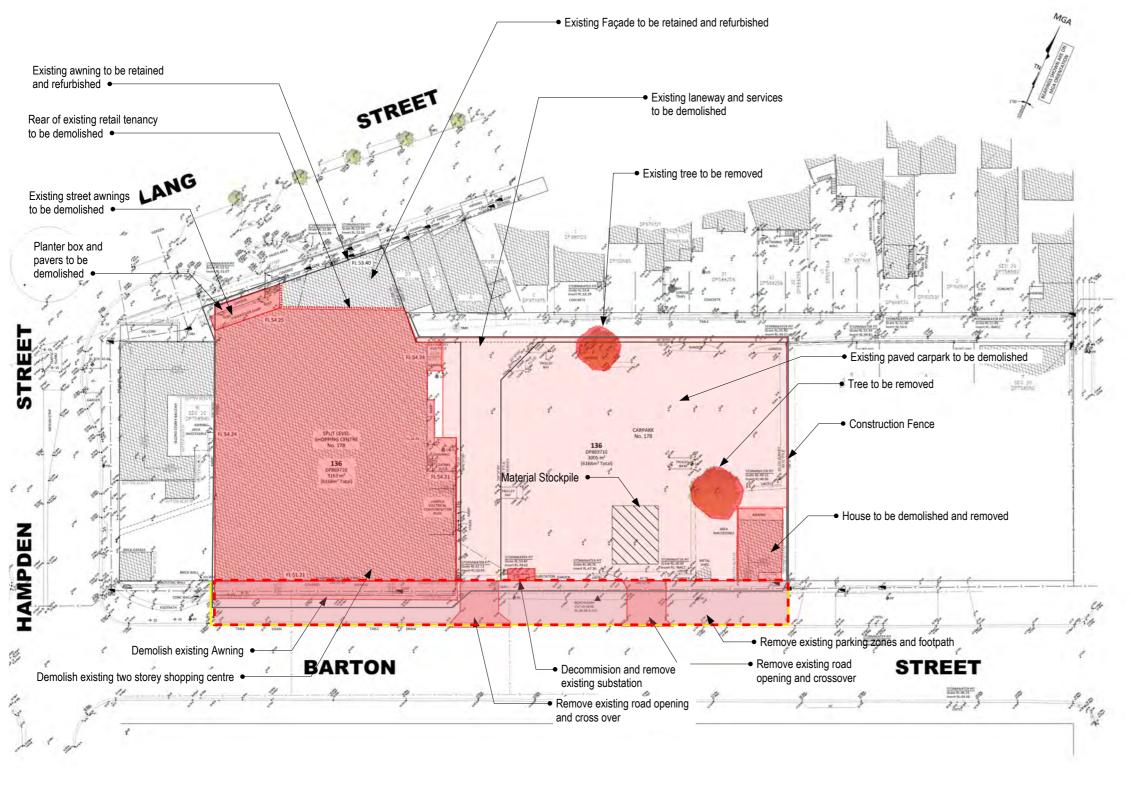

# DEMOLITION NOTES

CONTRACTOR TO CONFIRM EXISTING CONDITIONS ON SITE.

CONTRACTOR TO DEMOLISH EXISTING STRUCTURE/REMOVE ALL

PROTECTION OF WORKS AS REQUIRED BY LOCAL AUTHORITIES

CLEANING OF SITE TO EPA REQUIREMENTS BY CONTRACTOR

ASSESTOS

ASSESTOS

REMOVAL OF ALL ASSESTOS PRODUCTS. ALL ASSESTOS

PRODUCTS TO BE REMOVED & HANDLED AS PER RELEVANT

EXTENT OF DEMOLITION WORK AS INDICATED ON THIS DRAWING & HERITAGE CONSULTANTS DRAWINGS & SPECIFICATIONS. INCLUDING BUT NOT LIMITED TO THE FOLLOWING:

REMOVAL/DEMOLITION OF ALL EXISTING FLOOR/SLABS & FOOTINGS, EXTERNAL AND INTERNAL WALLS, WINDOWS, DOORS, CLADDING, GUTTERS, DOWNPIPES, RAINWATER HEADS, CAPPINGS, FLASHING GUTTER BOARD SUPPORTS ETC. U.N.O

REMOVAL/DEMOLITION OF ALL EXISTING WORKS INCLUDING BUT NOT LIMITED TO EXTERNAL STEPS, PATHS, CARPARKS, PLANTERS & LANDSCAPING, GATES, FENCES, GARDEN WALLS, RETAINING WALLS, BOLLARDS, LIGHT BLADES SIGNS, COLUMNS ETC. U.N.O

REMOVALIDEMOLITION OF ALL EXISTING FIXTURES AND FITTINGS INCLUDING BUT NOT LIMITED TO LIGHTS, TAPS, BASINS, WCS ETC. DISCONNECTION & REMOVAL OF EXISTING SERVICES TO BE UNDERTAKEN BY APPROPRIATE

CONTRACTOR TO MAKE GOOD DAMAGE TO ADJOINING BUILDINGS, PAVEMENT, LANEWAYS, ROADS, FENCES, KERBS, CHANNELS, SERVICES, STREET FURNITURE, CARSPACE MARKINGS ETC. (ILE ANY ADJOINING OBJECTSMATERIALS NOT WITHIN SITE BOUNDARY) RESULTING FROM DEMOLITION WORKS

ALL REPAIRS TO AUTHORITY REQUIREMENTS OR TO CONDITION PRIOR TO DEMOLITION. CONTRACTORS ARE RESPONSIBLE FOR RELOCATION AND CO-ORDINATION OF ROAD CARPARKING MARKINGS, TICKET MACHINES ETC.

THE TECHNIQUES ADOPTED FOR STRIPPING OUT AND FOR DEMOLITION SHALL MINIMISE THE RELEASE OF DUST INTO THE ATMOSPHERE, BEFORE THE COMMENCEMENT OF STRIPPING OF DEMOLITION IN AN AREA OF A STRUCTURE. ANY EXISTING ACCUMULATIONS OF DUST IN THAT AREA SHALL BE COLLECTED. PLACED IN SUITABLE CONTAINERS AND REMOVED. SELECTION OF AN APPROPRIATE COLLECTION TECHNIQUE, SUCH AS VACUUMING OR HOSING DOWN, SHALL TAKE DUE ACCOUNT OF THE NATURE OF THE DUST AND THE TYPE OF HAZARD IT PRESENTS. DUST GENERATED DURING STRIPPING, OR DURING THE BREAKING DOWN OF THE BUILDING FABRIC TO REMOVABLE SIZED PIECES, SHALL BE KEPT DAMP UNTIL IT IS REMOVED FROM THE SITE OR CAN BE OTHERWISE CONTAINED. THE USE OF EXCESS WATER FOR THIS PURPOSED SHALL BE AVOIDED.

DUST CONTROL

NOISE SHALL BE MINIMISED AS FAR AS PRACTICABLE, BY THE SELECTION OF APPROPRIATE METHODS AND EQUIPMENT, AND BY THE USE OF SILENCING DEVICES WHEREVER PRACTICABLE TO EPACODE REQUIREMENTS.

NOTE:

1. ATTENTION IS DRAWN TO RECOMMENDATIONS IN AS.2436

2. HOURS OF OPERATING EQUIPMENT MAY BE RESTRICTED BY REGULATORY AUTHORITY

FIRE SERVICES
WHERE A FIRE HYDRANT SERVICE OR A FIRE HOSE REEL
SERVICE IS PROVIDED IN A BUILDING, IT SHALL BE AVAILABLE AT
ALL TIMES DURING THE DEMOLITION OF THE BUILDING, SO THAT
ALL REMAINING STOREYS EXCEPT THE TWO UPPERMOST
STOREYS, ARE SERVICED, ACCESS TO THE FIRE PROTECTION
SERVICES, INCLUDING ANY BOOSTER FITTING, SHALL BE
MAINTAINED AT ALL TIMES, IF A SPRINKLER SYSTEM IS
INSTALLED IN A BUILDING TO BE DEMOLISHED, IT SHALL BE
MAINTAINED IN AN OPERABLE CONDITION AT EACH STOREY
BELOW THE TWO UPPERMOST UNSTRIPPED STOREYS.

SUITABLE PORTABLE FIRE EXTINGUISHERS SHALL BE KEPT AT ALL TIMES IN WORKING AREA AND ARE NOT PROTECTED BY OTHER FIRE SERVICES, AND MAINTAINED IN AN OPERABLE CONDITION.

PRELIMINARY
PRECAUTIONARY MEASURES TO BE UNDERTAKEN AS
DESCRIBED IN AS 2601-2001. A "HAZARDOUS SUBSTRANCES
MANAGEMENT PLAN" IS TO BE IMPLEMENTED BEFORE AND
DURING DEMOLITION IF THE PRELIMINARY INVESTIGATION OF
THE BULLONIS DENTIFIES ANY HAZARDOUS MATERIAL'S
CONTAINED THEREIN. THESE MATERIALS WILL BE REMOVED AS
PER THE GUIDELINES OF THE RESPONSIBLE AUTHORITY AND
CLEARANCE CERTIFICATE OBTAINED BEFORE DEMOLITION

# SAFETY FENCING

SAPE IT PENCING
SECURITY FENCES SHALL BE PROVIDED TO THE STREET
BOUNDARY OF THE DEMOLITION SITE AND ANY ADDITIONAL
PREVAITIONARY MEASURES, TAKEN AS MAY BE NECESSARY TO
PREVENT UNAUTHORISED ENTRY TO THE SITE, WHERE THE DEMOLITION SITE ADJOINS A PUBLIC THOROUGHFARE THE COMMON BOUNDARY BETWEEN THEM SHALL BE FENCED FOR ITS FULL LENGTH WITH A HOARDING UNLESS THE LEAST HORIZONTAL DISTANCE BETWEEN THE COMMON BOUNDARY AND THE NEAREST PART OF THE STRUCTURE IS GREATER THAN TWICE THE HEIGHT OF THE STRUCTURE. THE FENCING SHALL BE THE EQUIVALENT OF THE CHAIN WIRE AS SPECIFIED IN AS.1725

NOTICES LETTERED IN ACCORDANCE WITH AS.1319 AND DISPLAYING THE WORDS "WARNING DEMOLITION IN PROGRESS", OR SIMILAR, SHALL BE FIXED TO THE FENCING AT APPROPRIATE PLACES TO WARN THE PUBLIC. PROVISION SHALL BE MADE FOR READY ACCESS TO THE SITE BY EMERGENCY SERVICES PERSONNEL IN THE EVENT OF FIRE OR ACCIDENT

# DEMOLITION WORK

DEMOLITION WORK
STRUCTURES SHALL BE DEMOLISHED IN THE REVERSE ORDER
TO THAT OF THEIR CONSTRUCTION. THE ORDER OF DEMOLITION
FOR BUILDINGS SHALL BE PROGRESSIVE, STOREY BY STOREY,
HAVING PROPER REGARD TO THE TYPE OF CONSTRUCTION. NO
PART OF ANY STRUCTURE SHALL BE LEFT UNSUPPORTED OR PART OF ANT STROUGHE STARLE BE LETT ORSUPP FOR UP AN UNATTENDED IN SUICH A CONDITION THAT IT MAY COLLAPSE OR BECOME DANGEROUS, PRECAUTIONS SHALL BE TAKEN TO ENSURE THAT THE STABLITY OF ALL PARTS OF THE STRUCTURE. AND THE SAFETY OF PERSONS ON AND OUTSIDE THE SITE WILL BE MAINTAINED IN THE EVENT OF SUDDEN AND SEVERE WEATHER CHANGES.

WALLS ON THE BOUNDARIES ARE TO BE DEMOLISHED IN A SAFE AND WORKMANSHIP LIKE MANNER. WALLS SHALL NOT BE LATERALLY LOADED BY ACCUMULATED DEBRIS OR RUBBLE, TO THE EXTENT THAT THEY ARE IN DANGER OF COLLAPSE. ALLOWABLE LOADING OF THE SUSPENDED FLOORS SHALL BE DETERMINED BY AN INDEPENDENT STRUCTURAL ENGINEER.

# ADJOINING PROPERTIES

SAFE ACCESS TO AND EGRESS FROM ADJOINING BUILDINGS SHALL BE MAINTAINED AT ALL TIMES FOR THE DURATION OF THE DEMOLITION WORK, NO DEMOLITION ACTIVITY SHALL CAUSE DAMAGE TO OR ADVERSELY AFFECT THE STRUCTURAL INTEGRITY OF ADJOINING BUILDINGS. THE EFFECTS OF VIBRATION AND CONVERSION ON ADJOINING BUILDINGS AND THEIR OCCUPANTS SHALL BE MINIMISED BY SELECTING DEMOLITION METHODS AND EQUIPMENT APPROPRIATE TO THE CIRCUMSTANCES, WHERE ANY SURFACE OF AN ADJOINING BUILDING IS EXPOSED BY DEMOLITION, THE NEED FOR WEATHERPROOFING THE EXPOSED SURFACE SHALL BE INVESTIGATED AND TEMPORARY OR PERMANENT PROTECTION PROVIDED AS APPROPRIATE. PRECAUTIONS SHALL BE TAKEN TO MINIMISE THE SPREADING OF MUD AND DEBRIS BY VEHICLES LEAVING THE SITE.

GENERAL

OPENINGS IN EXISTING WALLS AND FLOORS, THROUGH WHICH
THERE IS A RISK OF PERSONS FALLING TO LOWER LEVEL, SHALL
BE EITHER PROPERLY GUARDED OR BOARDED OVER AND THE
BOARDING SECURED AGAINST UNAUTHORISED OR ACCIDENTAL
REMOVAL PRECAUTIONS SHALL BE TAKEN TO PREVENT GLASS
FROM FALLING ON ANY PERSON IN OR OUTSIDE THE BUILDING,
DEMOLISHED MATERIAL SHALL NOT BE ALLOWED TO FALL
FREELY OUTSIDE THE STRUCTURE UNLESS IT IS CONFINED
WITHIN A CHUTE OR SIMILAR ENCLOSURE, WHICH IS CLEAR OF
OBSTRUCTIONS TO OBJECTS FALLING FREELY.

DEMOLISHED MATERIAL SHALL BE REMOVED PROGRESSIVELY FROM THE SITE AND AT ANY TIME. SHALL NOT BE ALLOWED TO ACCUMULATE TO THE EXTENT THAT IT PRESENTS A HAZARD TO THE PUBLIC OR TO SITE PERSONNEL.

ALL DRAWINGS TO BE READ IN CONJUNCTION WITH HERITAGE CONSULTANTS DRAWINGS AND SPECIFICATIONS

# SITE PROTECTION/SHORING LEGEND PERMANENT SITE SHORING TEMPORARY SITE SHORING

REFER STRUCTURAL ENGINEERS DRAWINGS FOR ALL SITE





SECURITY FENCE

NORTH


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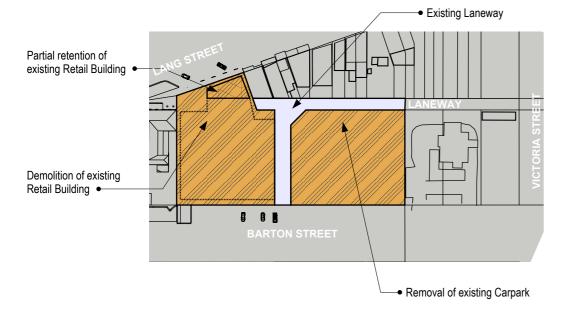
PROJECT TITLE: 174-178 LANG STREET, KURRI KURRI ISSUED FOR DEVELOPMENT APPLICATION Revision

Drawing Title Drawing Scale Issue Date


DEMOLITION PLAN 1:800@A3

21/08/2023 DA04




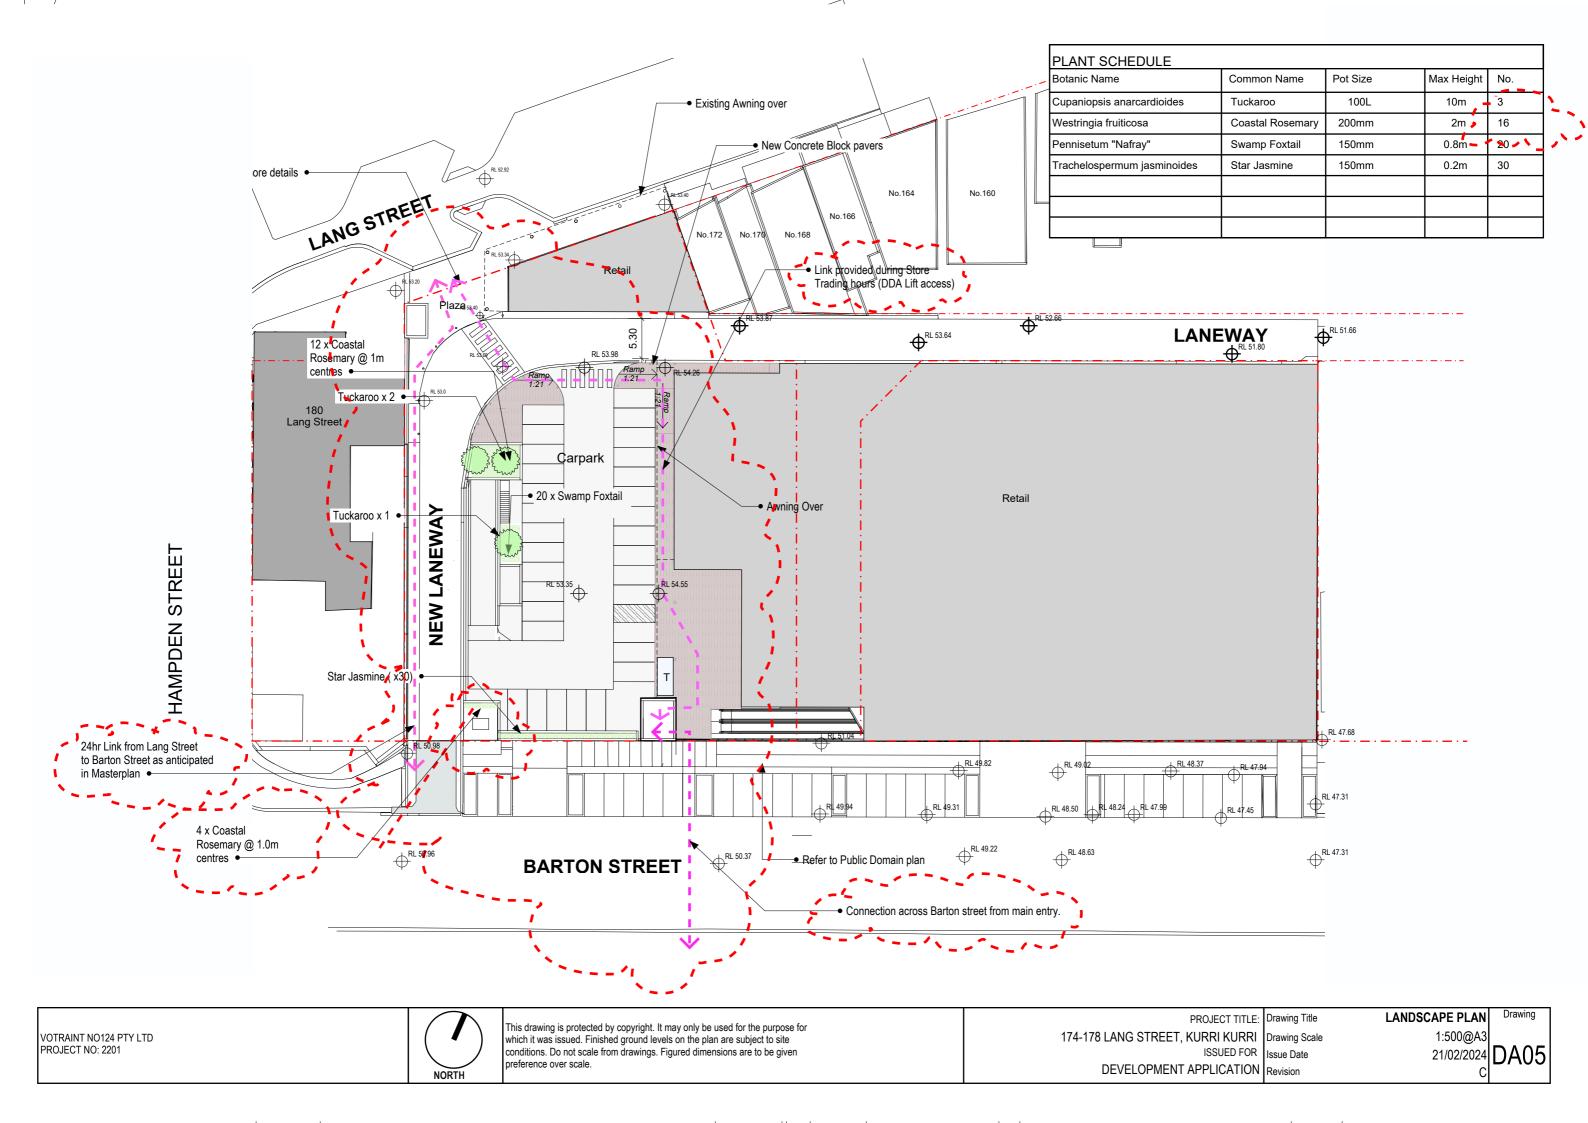


Stage 1 - Demolition

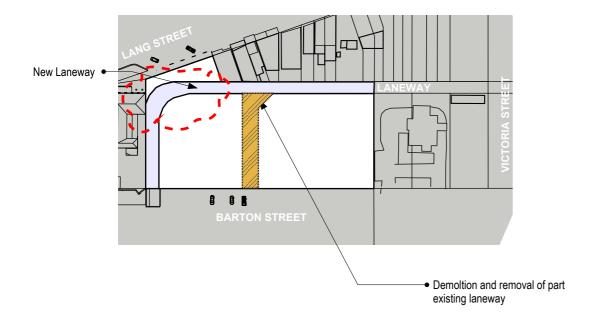


Stage 2b - Closure of Existing Lane and handover

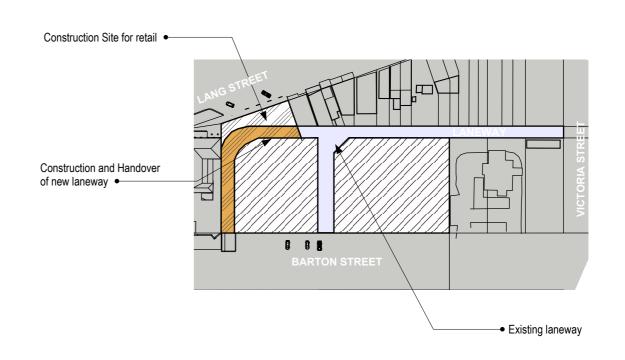


Stage 2a - Construction of laneway and Handover

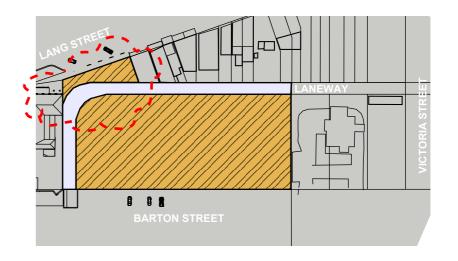

Stage 3 - Construction

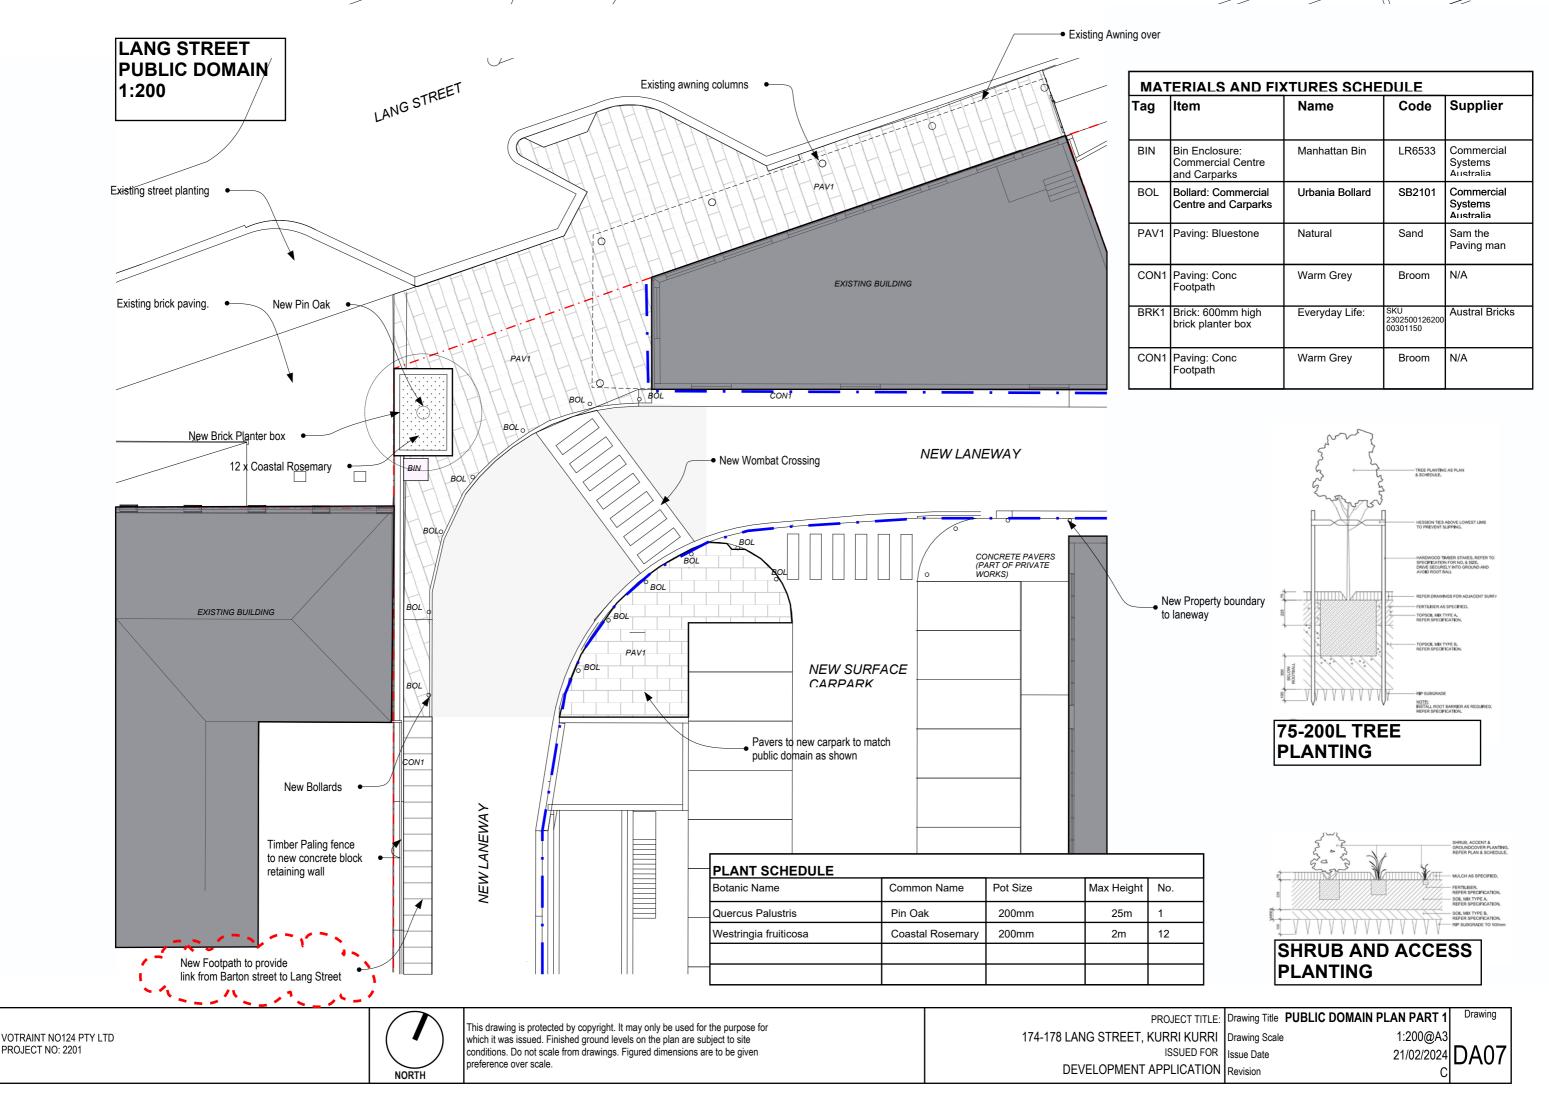

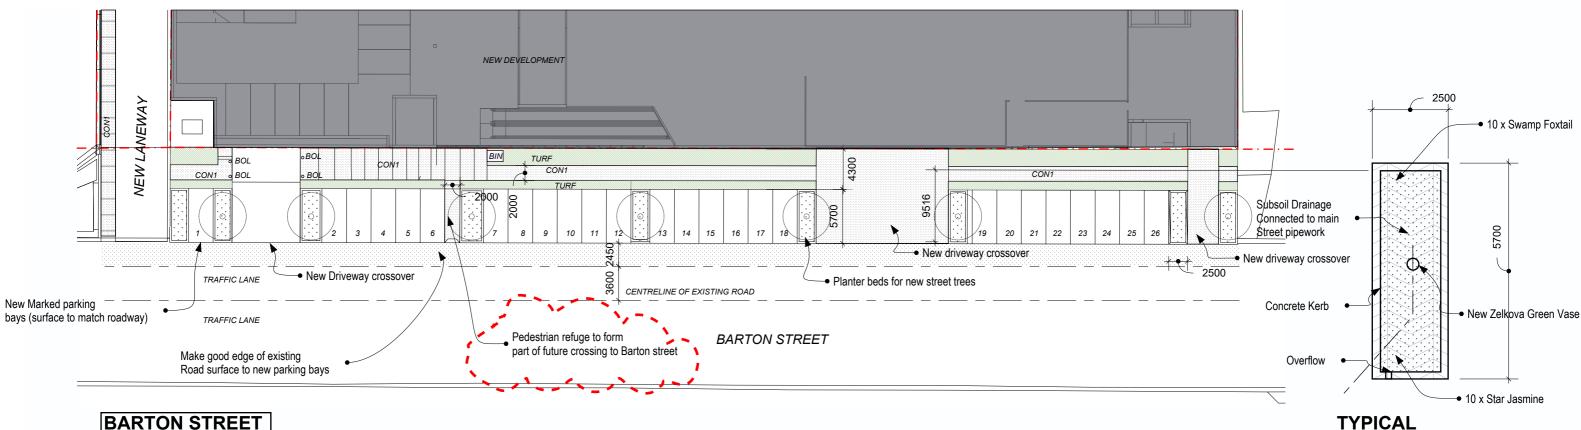

**BARTON STREET** PUBLIC DOMAIN 1:400

FITTINGS AND FIXTURES SCHEDULE Tag Item Code Supplier Name LR6533 Bin Enclosure: Manhattan Bin Commercial Commercial Centre Systems and Carparks Δiıstralia Bollard: Commercial Urbania Bollard SB2101 Commercial Centre and Carparks Systems Australia PAV1 Paving: Bluestone Natural Sam the Paving man N/A CON1 Paving: Conc Warm Grey Broom Footpath BRK1 Brick: 600mm high Everyday Life: Austral Bricks 2302500126200 00301150 brick planter box CON1 Paving: Conc Warm Grey Broom Footpath


Barton street upgrades in accordance with "Barton St East" section of Commercial Centre Masterplan

ZELKOVA ZELKOVA SERRATA "GREEN VASE"

en Vase Oak stal Rosemary	100L 200mm	14m 25m 2m	7
			1
stal Rosemary	200mm	2000	40
		2111	12
mp Foxtail	150mm	0.8m	50
Jasmine	150mm	0.2m	100
	Jasmine	· ·	

SHRUB AND ACCESS PLANTING

**TURF ON EVEN** GRADE

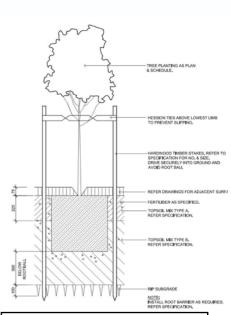

**PLANTING BED** 


(1:100)

75-200L TREE **PLANTING** 

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PROJECT TITLE: 174-178 LANG STREET, KURRI KURRI Drawing Scale ISSUED FOR Issue Date

Drawing Title PUBLIC DOMAIN PLAN PART 2 1:200@A3 21/02/2024 DA08 DEVELOPMENT APPLICATION Revision

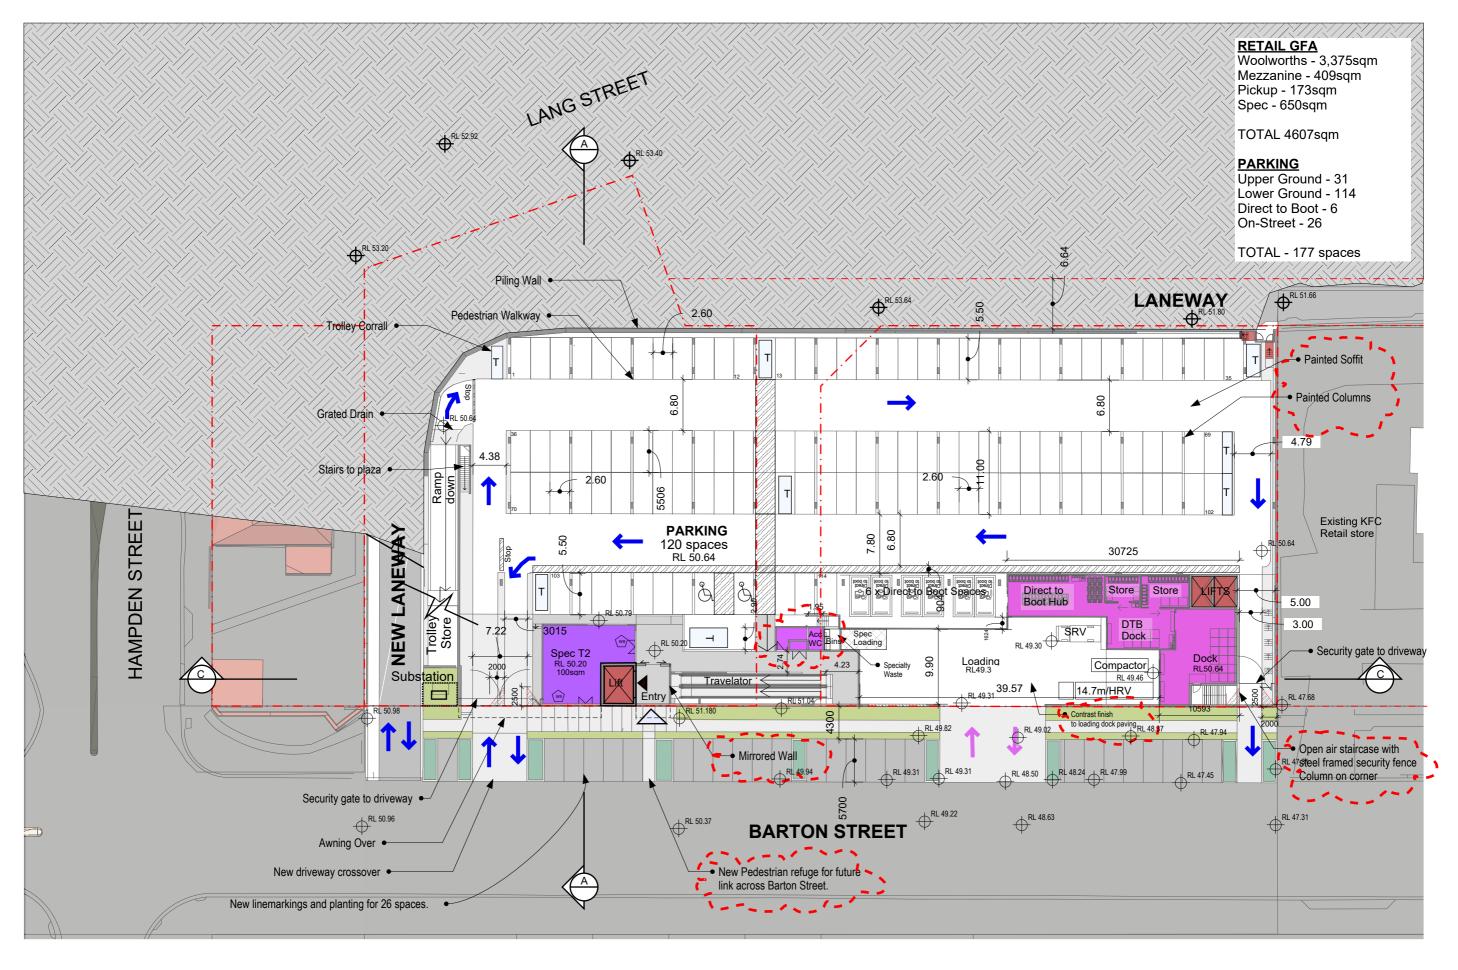

NORTH

VOTRAINT NO124 PTY LTD

PROJECT NO: 2201


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PROJECT TITLE: Drawing Title

174-178 LANG STREET, KURRI KURRI
ISSUED FOR Issue Date
DEVELOPMENT APPLICATION Revision

LOWER GROUND FLOOR 1:500@A3

1:500@A3 21/02/2024 C

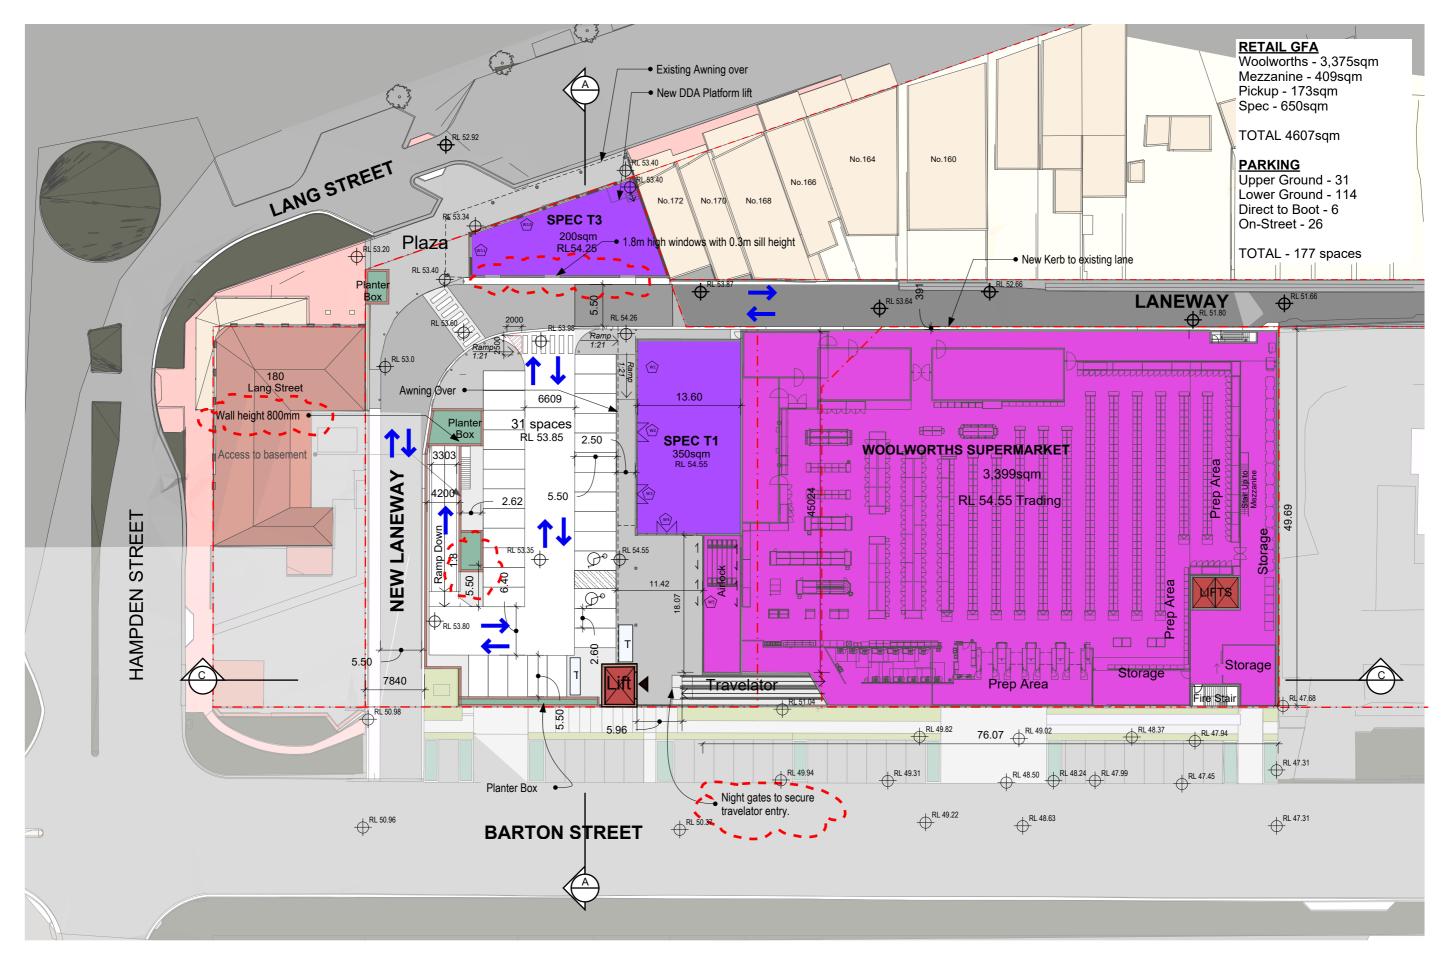

VOTRAINT NO124 PTY LTD PROJECT NO: 2201 NORTH


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PROJECT TITLE: Drawing Title 174-178 LANG STREET, KURRI KURRI ISSUED FOR DEVELOPMENT APPLICATION Revision

Drawing Scale Issue Date

UPPER GROUND FLOOR 1:500@A3

21/02/2024 DA11

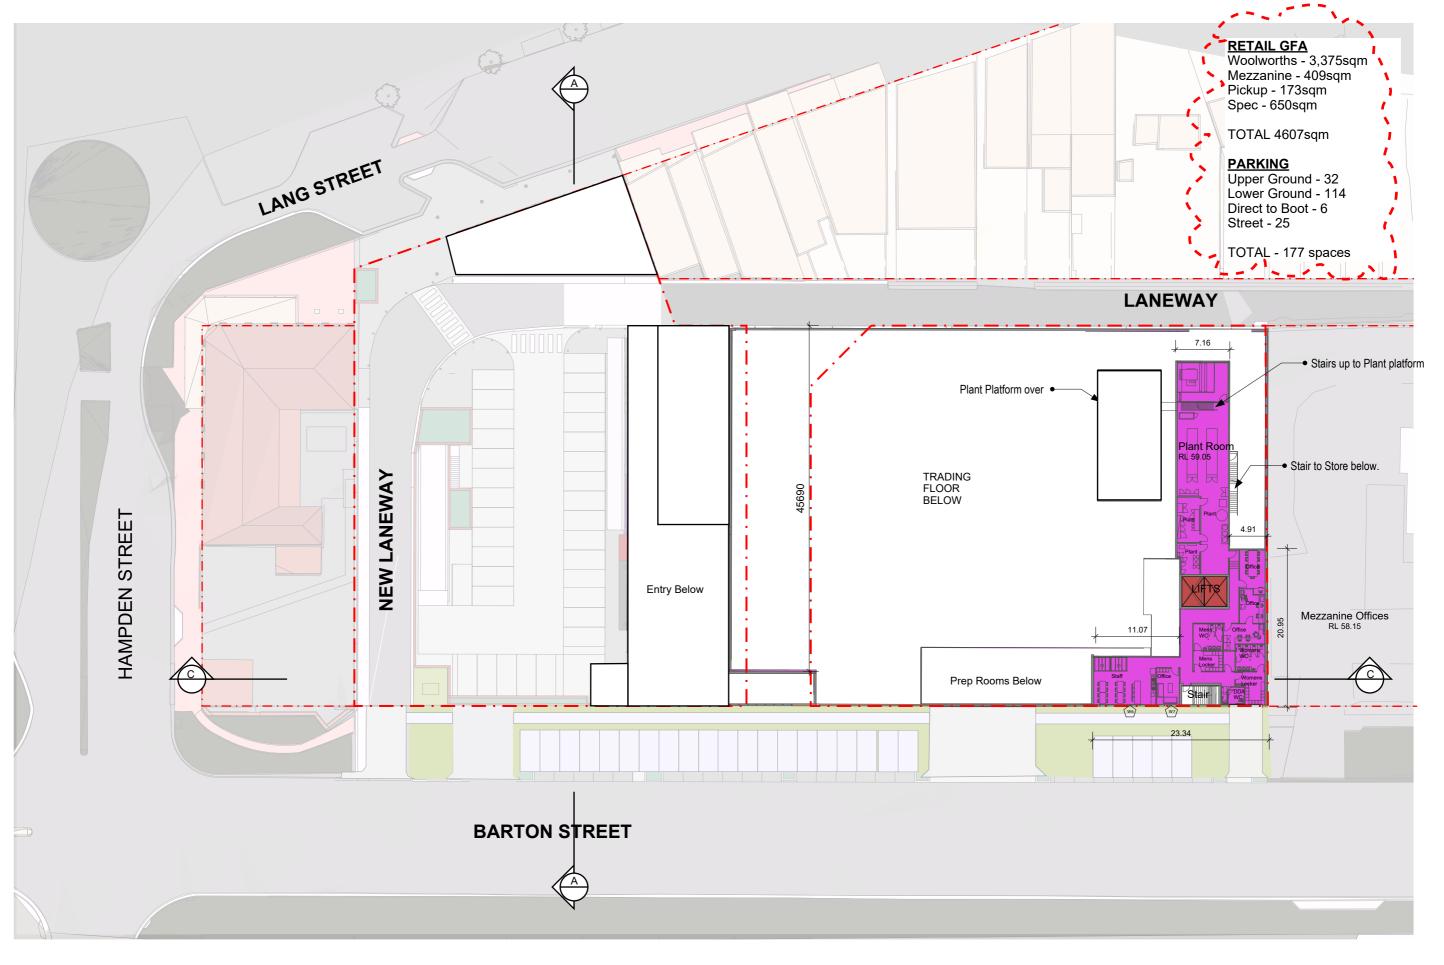

VOTRAINT NO124 PTY LTD PROJECT NO: 2201




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PROJECT TITLE: Drawing Title 174-178 LANG STREET, KURRI KURRI Drawing Scale ISSUED FOR Issue Date DEVELOPMENT APPLICATION Revision

MEZZANINE FLOOR 1:500@A3

21/08/2023 DA12

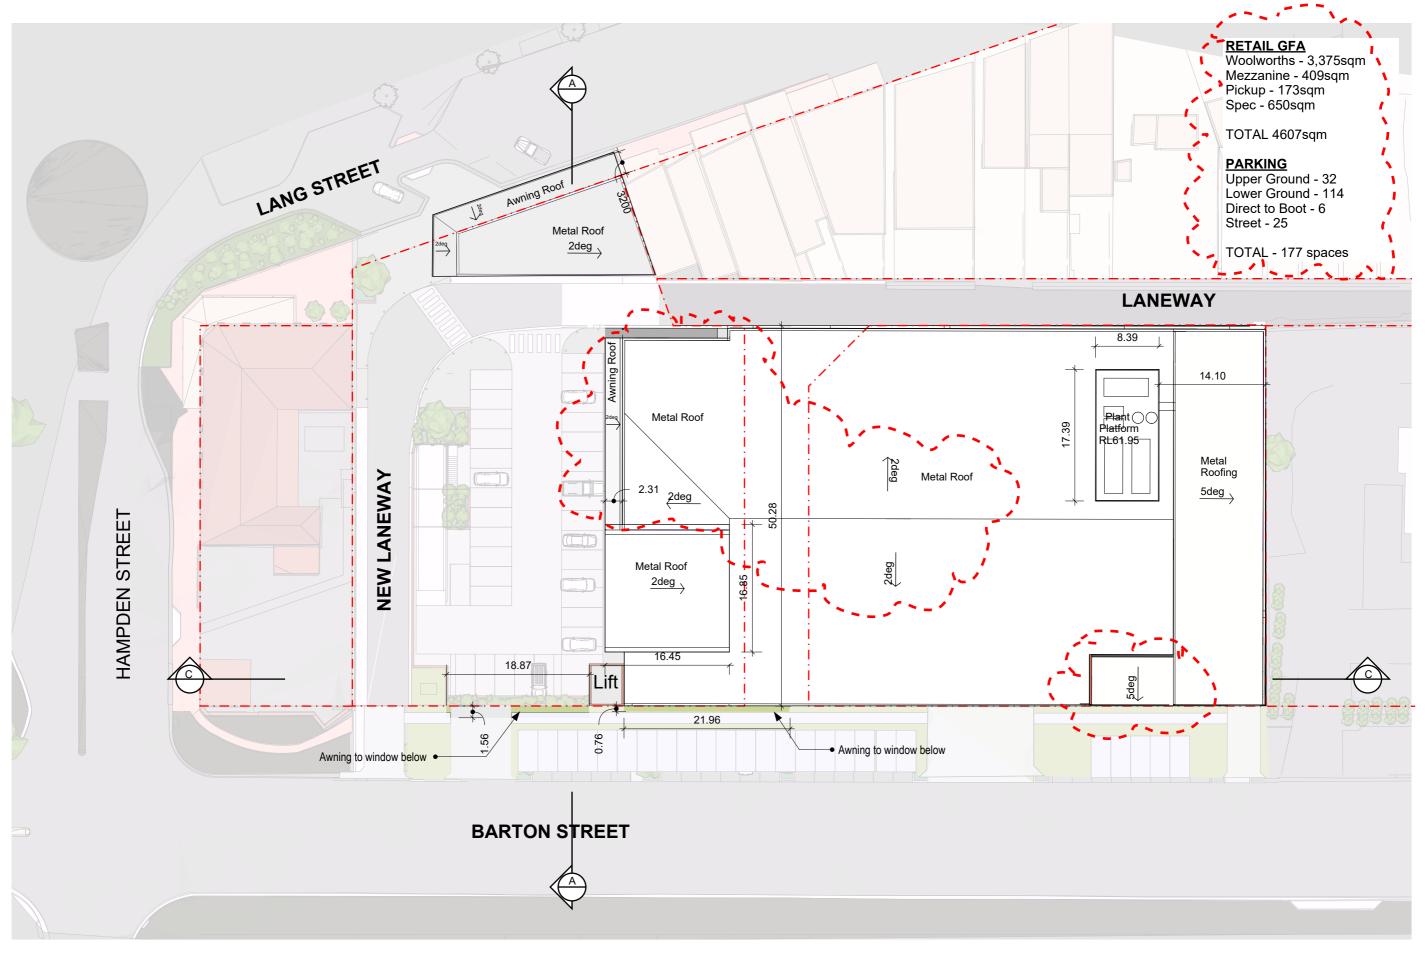

VOTRAINT NO124 PTY LTD PROJECT NO: 2201




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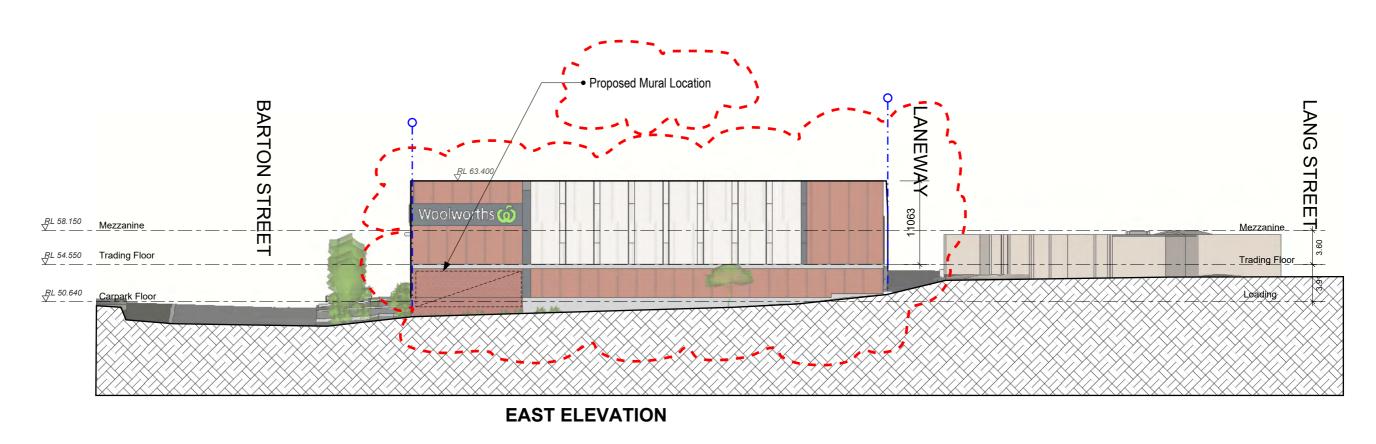
PROJECT TITLE: Drawing Title 174-178 LANG STREET, KURRI KURRI Drawing Scale ISSUED FOR Issue Date DEVELOPMENT APPLICATION Revision

ROOF LEVEL 1:500@A3

21/08/2023 DA13

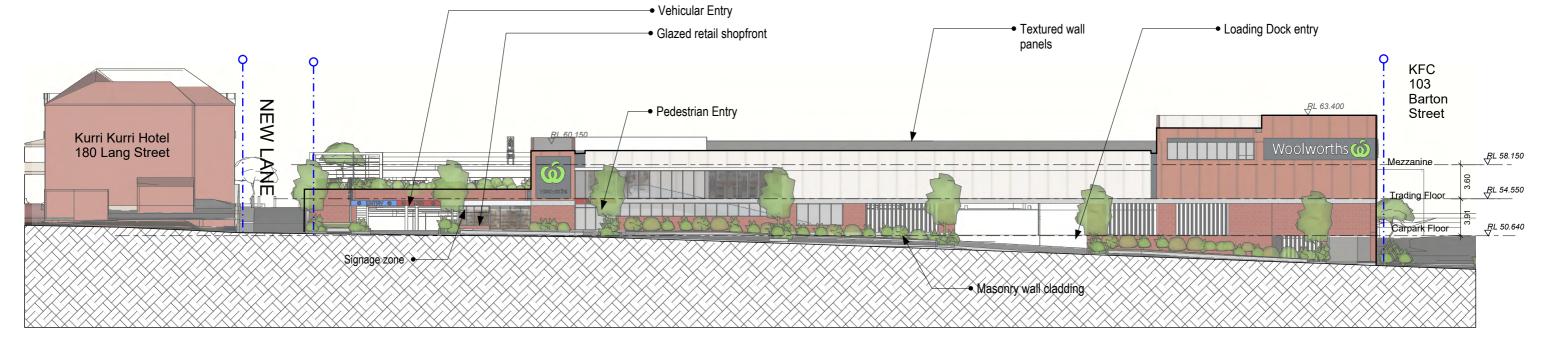

# **SOUTH ELEVATION (BARTON STREET)**



# BRK1 - Brickwork CON1 - Masonry Wall Panels CON2 - Concrete Textured PD1 - Powdercoated Window Frames CON3 - Concrete Blockwork PD2 - Powdercoated Screens


MATERIALS LEGEND

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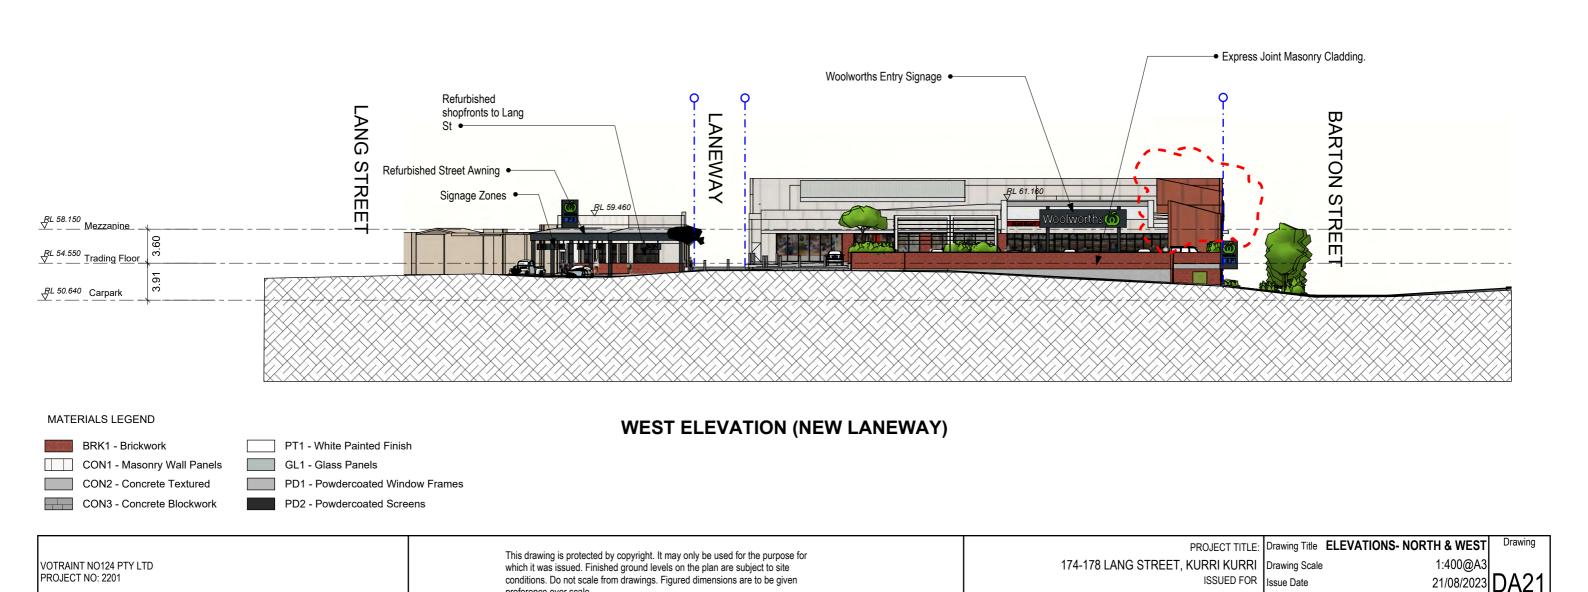
PROJECT TITLE: Drawing Title I 174-178 LANG STREET, KURRI KURRI ISSUED FOR DEVELOPMENT APPLICATION Revision

Drawing Title **ELEVATIONS - SOUTH & EAST**Drawing Scale 1:400@A3
Issue Date 21/02/2024
Revision

1:400@A3 21/02/2024 C

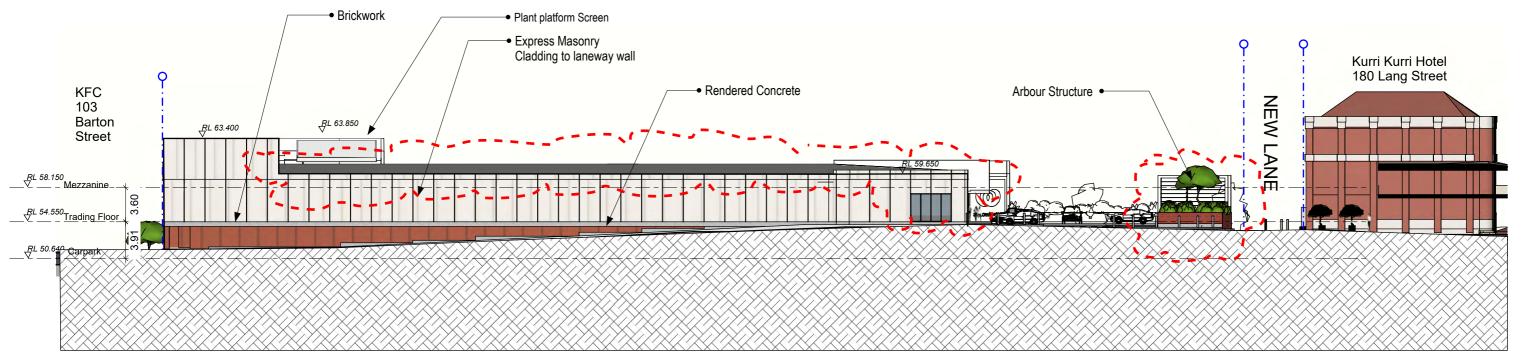


# **NORTH ELEVATION (LANEWAY)**




DEVELOPMENT APPLICATION Revision


preference over scale.

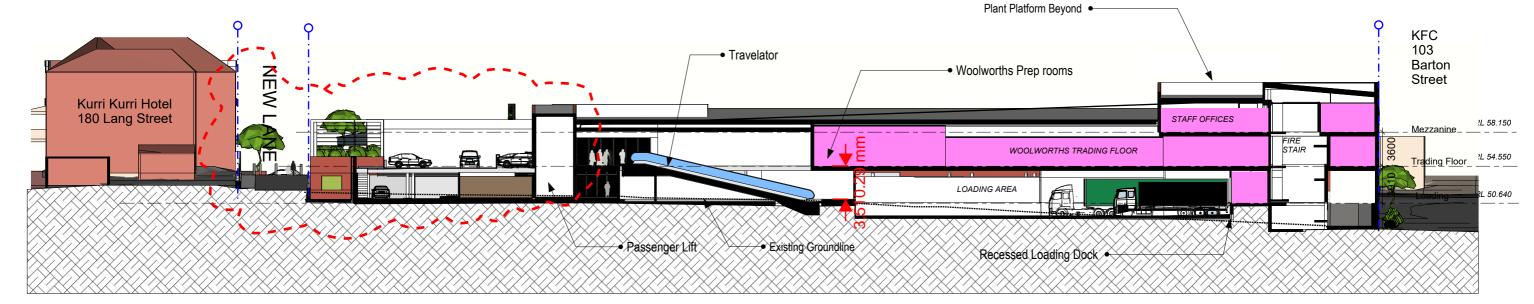

**SECTION C-C** 

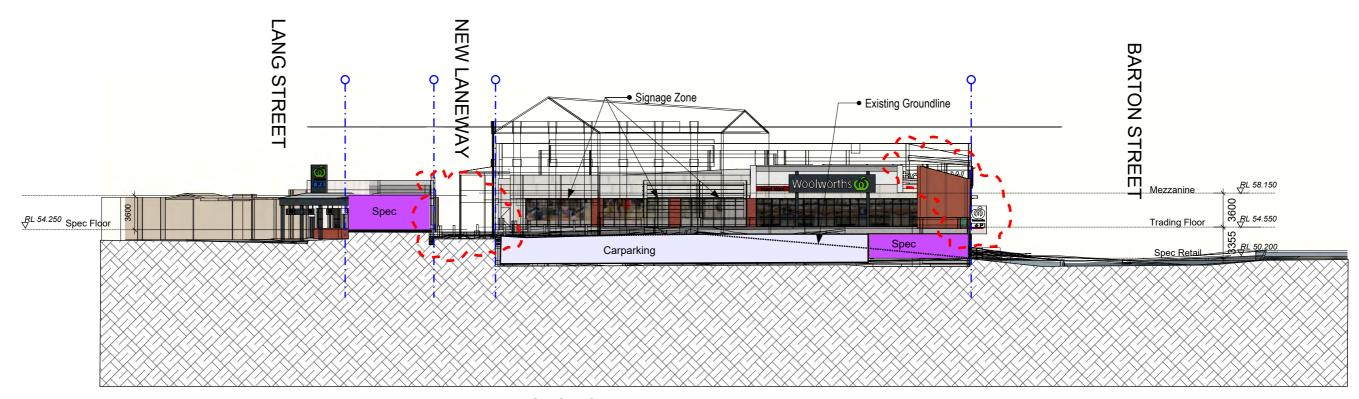

**SECTION A-A** 

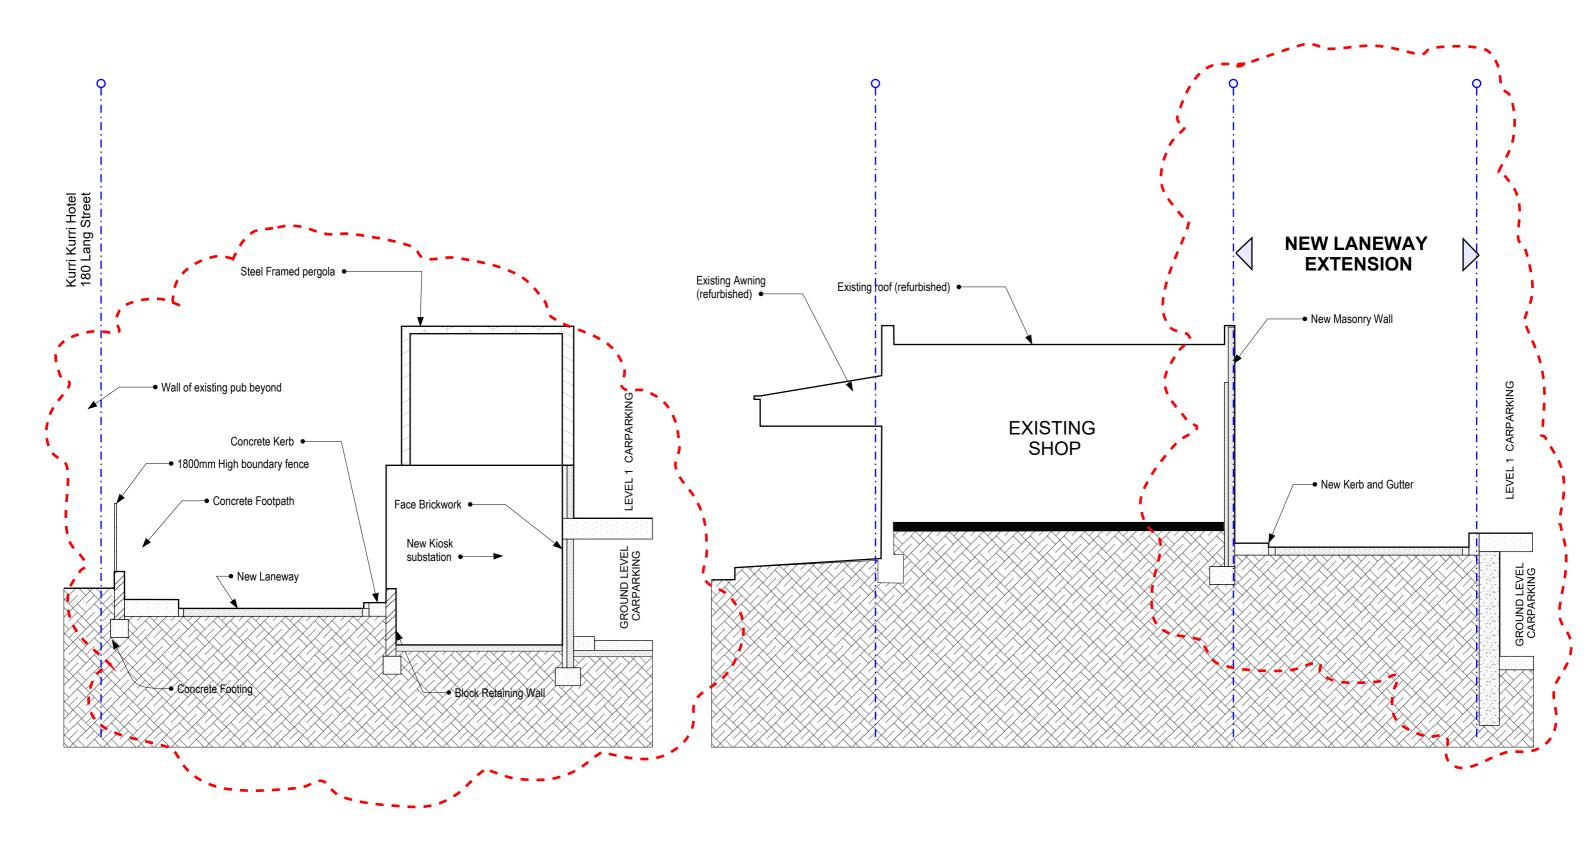

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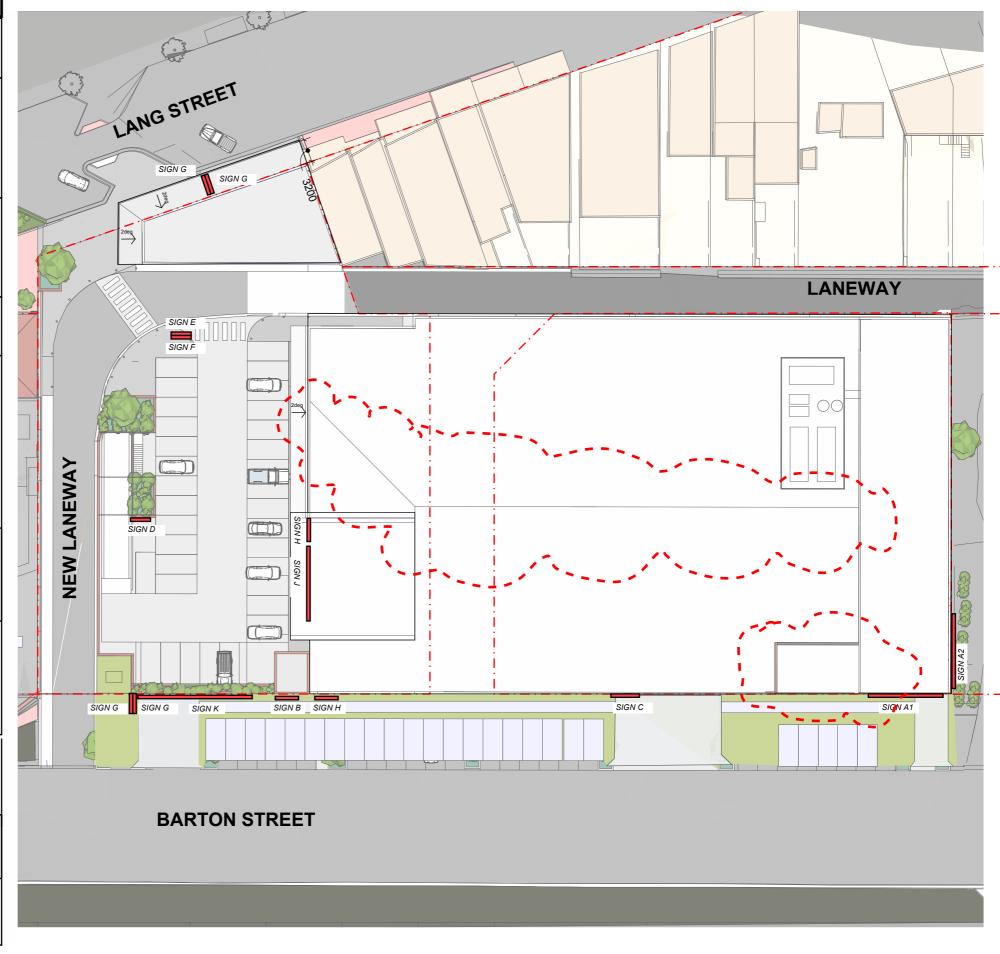
PROJECT TITLE: Drawing Title

174-178 LANG STREET, KURRI KURRI
ISSUED FOR ISSUE Date
DEVELOPMENT APPLICATION Revision

g Title DETAIL SECTIONS
g Scale 1:100@A3

1:100@A3 21/08/2023 B

TYPE	GRAPHIC	DESCRIPTION	AREA
SIGN A x 2	Woolworths 6	Internally illuminated sign	16.5sqm
SIGN B	Woolworths	Internally illuminated Sign	14.4sqm
SIGN C	Loading dock	2d non- illuminated sign	1.2sqm
SIGN D	Please return your trolley here  Trolley bay  HALLANDOADE  MODOTRAIT	2d non- illuminated sign	0.6sqm 1.2sqm
SIGN E	s Woolworths P	Internally illuminated signage with vinyl face	1.44sqm
SIGN F	Thank you	2d non- illuminated signage	1.44sqm
SIGN G	1800 Woolworths	Internally illuminated signage with vinyl face	5.4sqm
SIGN H	Kurri Kurri	Internally illuminated signage with vinyl face	2.2sqm
SIGN J	Woolworths 6	Internally illuminated sign	16.5sqm
SIGN K	9400  SENTRY O SEXIT O	Internally illuminated signage with vinyl face	4.7sqm




VOTRAINT NO124 PTY LTD PROJECT NO: 2201




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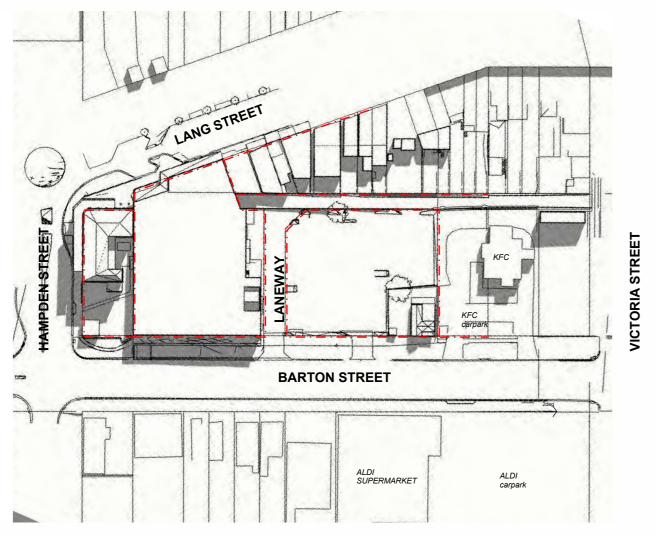
SIGNAGE SCHEDULE NTS@A3 21/08/2023 DA26




**9AM JUNE 22ND - EXISTING** 

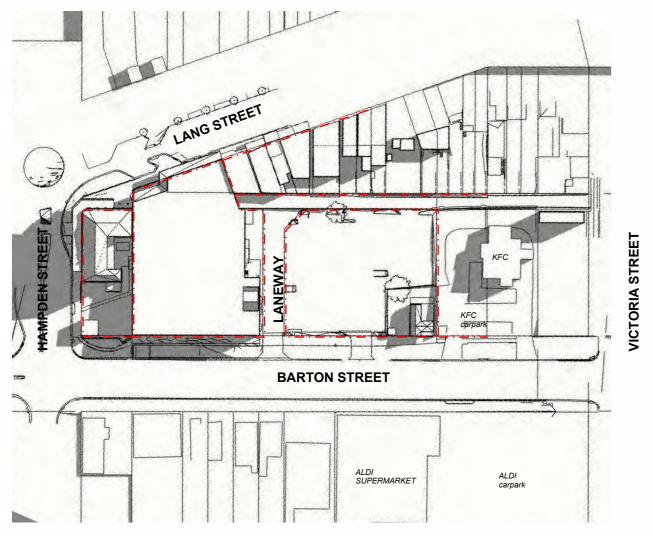


12PM JUNE 22ND - PROPOSED

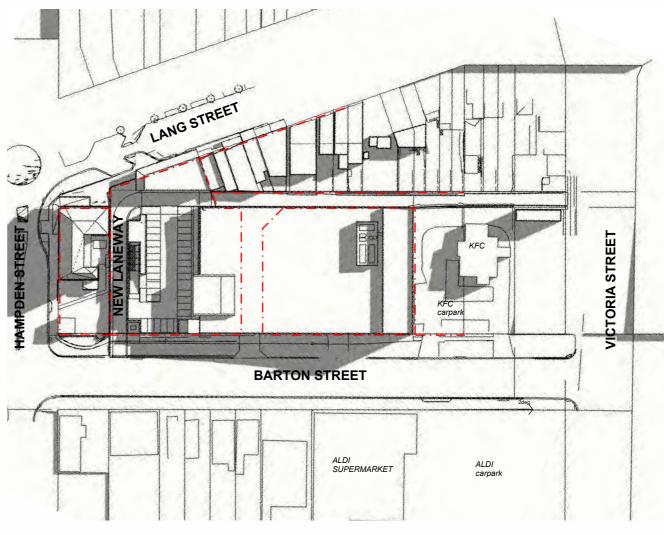


**9AM JUNE 22ND - EXISTING** 

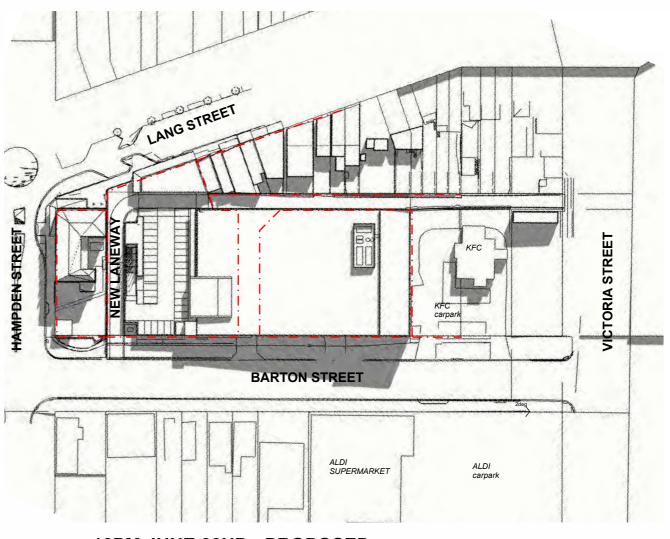

12PM JUNE 22ND - PROPOSED

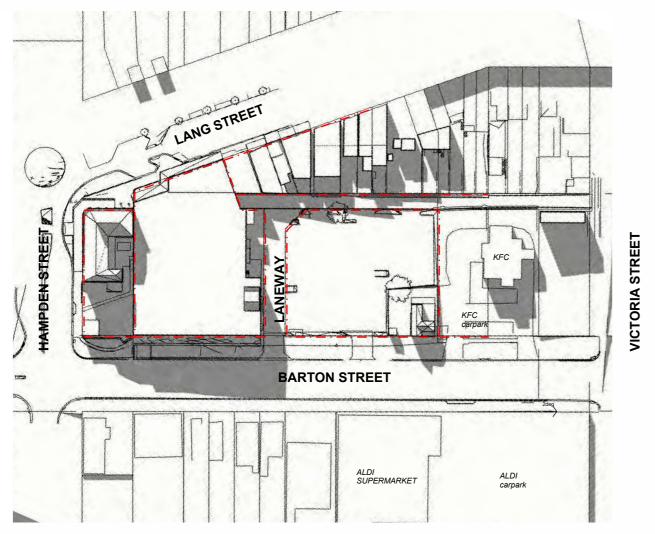

**9AM JUNE 22ND - EXISTING** 

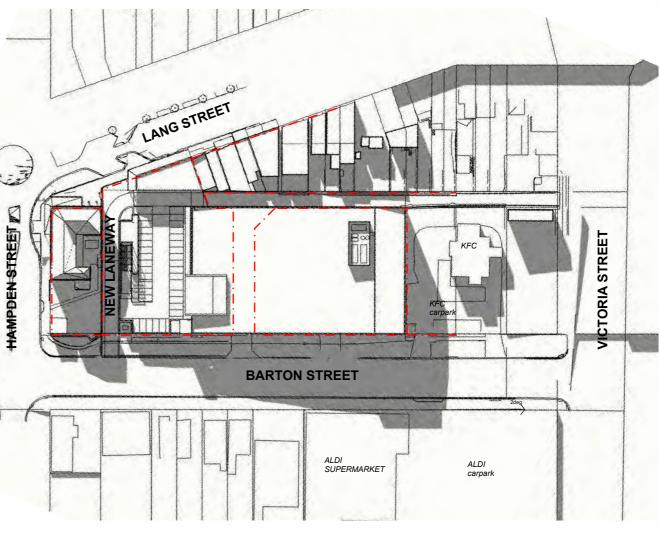

12PM JUNE 22ND - PROPOSED





# **MATERIALS LEGEND**

	_	
		BRK1 - Brickwork
,		CON1 - Masonry Wall Panels Off White
		CON4 - Masonry Wall Panels Oxide
^	- /\ -	CON2 - Concrete Textured
		CON3 - Concrete Blockwork
		PT1 - White Painted Finish
		GL1 - Glass Panels
		PD1 - Powdercoated Window Frames
		PD2 - Powdercoated Screens
		PAV1 - Concrete Pavers
		PAV2 - Brick Pavers

# Perspective


View from new on grade parking towards supermarket entry point.

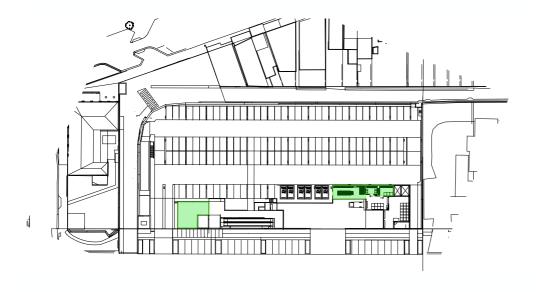

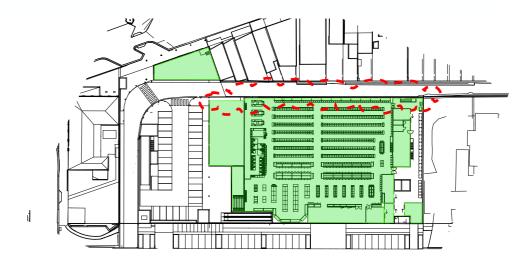

**LOWER GROUND PLAN** 1:1500@A3

**GROUND PLAN** 1:1500@A3

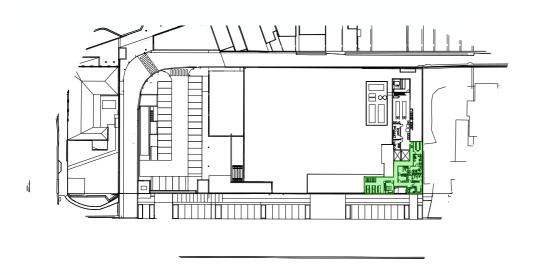

**GFA CALCULATIONS** Lower Ground - 211.79sqm Ground - 3,695.72sqm Mezzanine - 231.9sqm

**MEZZANINE PLAN** 1:1500@A3